




### SITE PLAN

SCALE: 1"= 20'



### VICINITY MAP

SCALE: 1"=100'

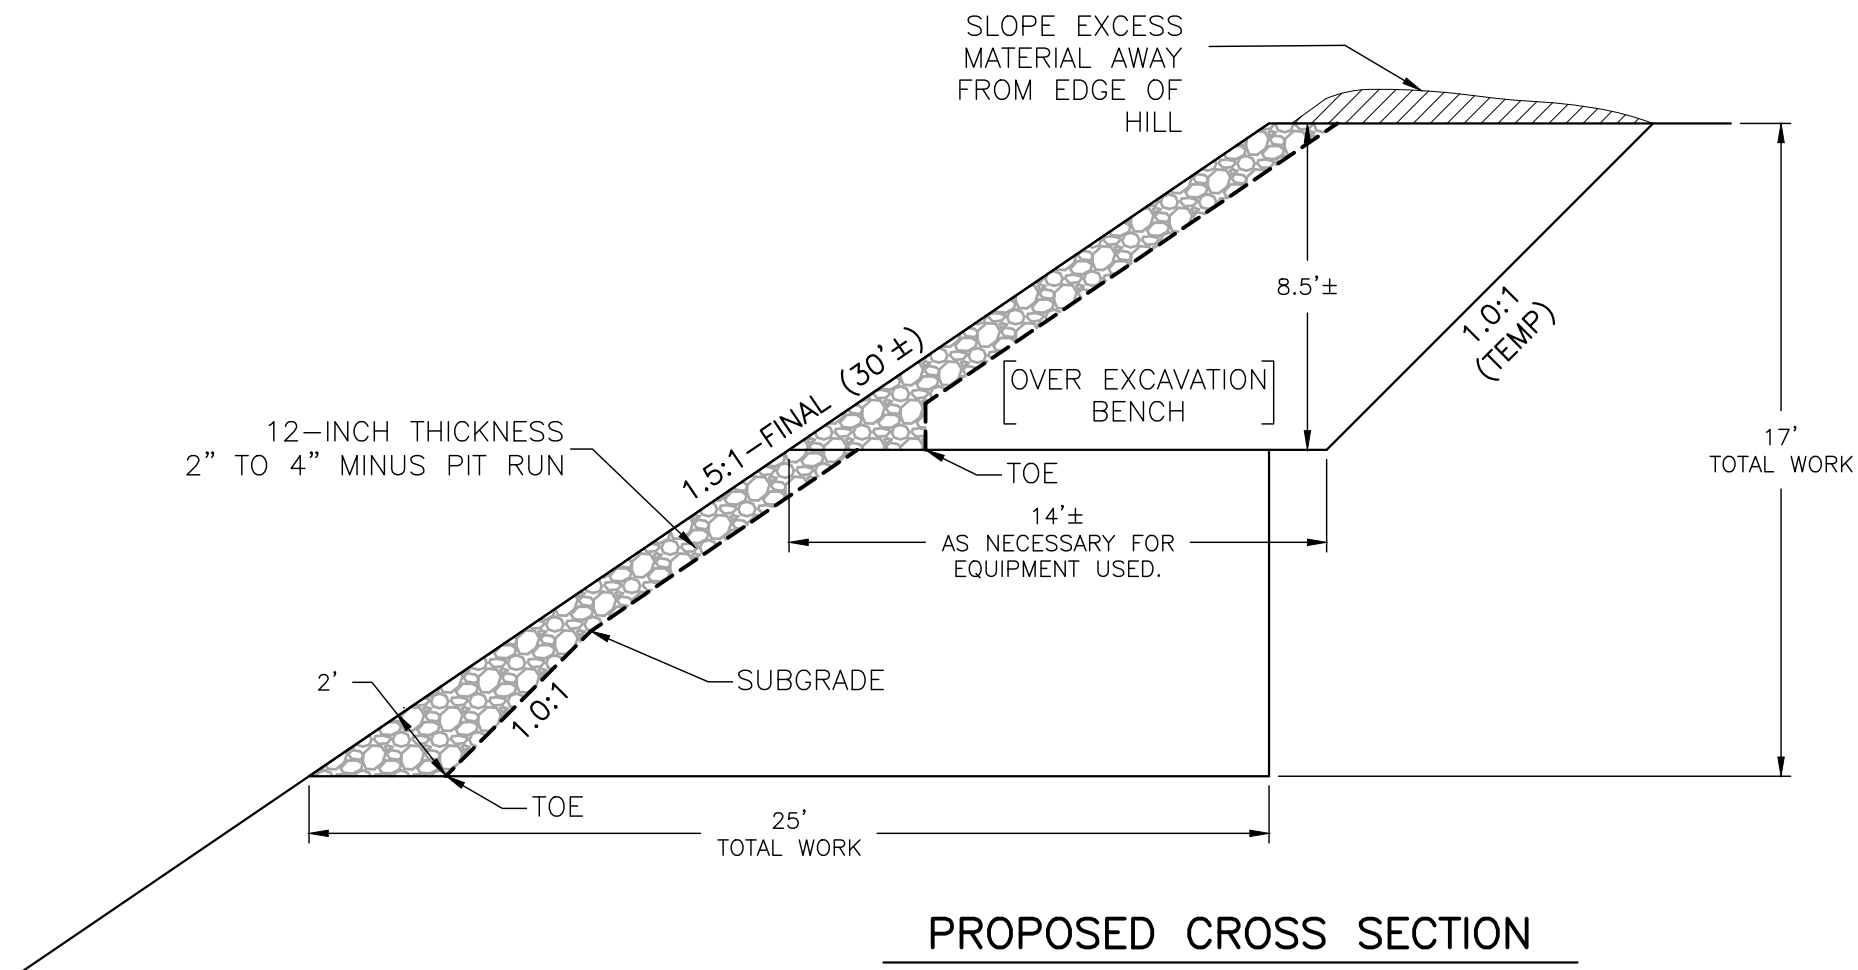

### PROPOSED CROSS SECTION

SCALE: 1"= 5'

### NOTES:

1. REMOVE TOPSOIL.
2. EXCAVATE BENCH AS NECESSARY FOR EQUIPMENT TO REACH LOWER LIMIT OF WORK AREA.
3. REMOVE EXISTING SOILS TO SHAPE SUBGRADE AS SHOWN, WITH TOE.
4. PLACE 12-INCH THICKNESS OF 2" TO 4" MINUS PIT RUN. HAND WORK MAY BE NECESSARY TO PROVIDE UNIFORM FINISHED SURFACE.
5. BACKFILL OVER-EXCAVATION BENCH WITH MOISTURE AND DENSITY CONTROL.
6. REPEAT NOTE 5 TO COVER OVER-EXCAVATION BENCH AREA.
7. SHAPE EXCESS EXCAVATION MATERIAL AS DIRECTED BY OWNER.
8. REPLACE TOPSOIL OVER DISTURBED AREA AND EXCESS MATERIAL SHAPING AREA.
9. RE-SEED TOPSOIL AREA.

P:\2019\19036 Borkenhagen - East Sheridan Hill\acad\BASE.dwg DETAIL - 11X17 5/30/19 ROB

DATE	DRAWING LOG	BY	CHECKED	APPROVED	DRAWN BY: IKSM
5/25/21	YEARLY EDITS	IKSM	CAS		JOB NO. 19036
5/22/19	ADD NOTES	LU	RAO	RAO	FIELD BOOK NO. N/A
5/9/19	ORIGINAL DRAWING	IKSM	RAO	RAO	



**ENGINEERING ASSOCIATES**  
**CONSULTING ENGINEERS & SURVEYORS**

OWNER:

**G. BORKENHAGEN**

PROJECT:

**EAST SHERIDAN AVENUE**

TITLE:

**HILLSIDE RECLAMATION WORK**

**C1.0**